

**H22-19**  
**Hotel Redevelopment**  
**REVISED**

Property Owner: Legacy Hotel of Medina LLC  
Applicant: Jim Gerspacher  
Location: 257 South Court Street  
Zoning: C-2 (Central Business)  
Request: Certificate of Appropriateness revisions for the construction of a hotel

**LOCATION AND SURROUNDING USES**

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The subject property encompasses 1.48 acres located between South Court Street and South Elmwood Avenue. Adjacent properties include the following uses:

- North – Retail and Parking
- East – Retail and Entertainment
- South – Fitness Center and Parking
- West – Parking and Residential



**BACKGROUND & PROPOSED APPLICATION**

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November 9, 2022 - The Historic Preservation Board (HPB), conditionally approved application H22-19 for the demolition of two principal structures and the construction of a hotel.

October 12, 2023 – The HPB extended the conditional approval.

March 14, 2024 – The HPB approved an amendment to the conditions of approval. The HPB also approved a separate application, H24-06, for the demolition of a building at 226 South Elmwood Avenue (NAPA) and the construction of an event center.

May 9, 2024 – The HPB approved revisions to the building's footprint, height, and building elevations.

October 10, 2024 – The HPB approved revisions to the south and east sides of the first floor of the building and minor site changes.

Current Application - Modifications to the top floor of the east elevation and miscellaneous minor changes.

### **REVISED PLANS**

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#### **East Side (Facing South Court Street)**

- Removal of transom windows near the main entrance
- Specification of four wall sconces from Millennium Lighting
- Adjustment to the fourth floor parapet height

#### **West Side (Facing South Elmwood Ave. and the proposed Event Center)**

- Removal of an awning over a rear staff access door

#### **North Side (Facing The Raspberry and the Rose)**

- Two flush mounted doors with an awning replaced with recessed doors
- Adjustment to the fourth floor parapet height

#### **South Side (Facing the Feckley Parking Lot)**

- Replacement of a wall of glass doors and top floor balcony with nine windows
- Removal of a door
- Adjustment to the fourth floor parapet height

### **DESIGN GUIDELINES (MEDINA CODIFIED ORDINANCES SECTION 145.07(b))**

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- (b) Additions/new construction. With respect to additions/new construction to existing buildings and all new buildings or structures within Historic Districts, it is generally the interest of the Board that such additions/new construction shall be designed to enhance the character of the Historic District. Consistent with the preface of this Chapter, new buildings and additions should be representative of architectural design and construction of contemporary times.

Additions to existing buildings in the Historic District should be designed so as not to detract from the original character of the building. Whenever possible, additions should be located away from the primary or street face of the building. The addition should be designed so as not to destroy existing architectural features, such that the addition can be removed and the building restored to its original condition.

New buildings in the Historic District shall be designed to be compatible with other structures in the Historic District while still reflecting work of contemporary times. Proximity of existing buildings to the new building will affect the latitude in design constraints. An infill design should be more consistent with adjoining buildings than a freestanding structure.

### **COMMUNITY DEVELOPMENT DEPARTMENT STAFF RECOMMENDATION**

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Staff recommends revised approval of H22-19 retaining the following condition from the previous approval: The applicant shall repair any unreasonable damage to the building at 241 South Court Street caused by the demolition of buildings at 253 or 257 South Court Street.



SLATE LOOK SHINGLE ROOF  
ECO STAR MAJESTIC SLATE  
TRADITIONAL CLASS C  
COLOR: CHESTNUT BROWN,  
FEDERAL GRAY, CEDAR  
BROWN, MOUNTAIN PLUM,  
DRIFTWOOD

FIBER CEMENT PANEL  
PRIMED AND PAINTED,  
COLOR: PANDA WHITE  
SW 6147

FIBERGLASS CORNICE  
ARCHITECTURAL  
FIBERGLASS C-332. NO  
CHANGE TO PROPOSED  
COLOR PALETTE

BRICK VENEER,  
GLEN-GERY: OLDE DETROIT  
SIGNAGE TO BE DETERMINED  
AT A FUTURE DATE

BRICK REVEAL DETAIL

STO LIMESTONE

SOLDIER COURSE DETAIL

ANODIZED ALUMINUM FIXED  
WINDOW, LOW-E GLASS,  
FRAME COLOR: DARK BRONZE,  
AWNING, COLOR: HOGAN  
ADMIRAL

ANODIZED ALUMINUM FIXED  
WINDOW, LOW-E GLASS,  
FRAME COLOR: DARK BRONZE

FIBER CEMENT AND MDO  
TRIM. COLOR: NEEDLEPOINT  
NAVY SW 0032

CAST STONE BASE

CANOPY, COLOR: BRONZE

BOLLARD (FLAT TOP), COLOR: BLACK

+ 66'-11"

+ 71'-0"

+ 53'-3"

TOP OF ROOF  
71'-0"

ROOF  
61'-0"

PARAPET  
53'-3"

FIFTH FLOOR  
47'-10 1/4"

FOURTH FLOOR  
36'-7 5/8"

THIRD FLOOR  
25'-9 7/8"

SECOND FLOOR  
15'-0"

ARRISCRAFT -  
RENAISSANCE  
MASONRY UNITS,  
COLOR: LIMESTONE,  
FINISH: SATIN

FIRST FLOOR  
0'-0"

1

ELEVATION HOTEL - EAST ELEVATION

1" = 10'-0"

1" = 10'-0"

0 10' 20' 30'



MEDINA HOTEL - EVENT CENTER  
DATE: SEPTEMBER 30, 2024  
PROJECT NO. 14423

APPROVED 10/10/24

PROJECT INFORMATION

SHEET NAME

HOTEL - EAST EXTERIOR  
ELEVATION

SHEET NO.

HSK01



SLATE LOOK SHINGLE ROOF  
ECO STAR MAJESTIC SLATE  
TRADITIONAL CLASS C  
COLOR: CHESTNUT BROWN,  
FEDERAL GRAY, CEDAR  
BROWN, MOUNTAIN PLUM,  
DRIFTWOOD

FIBER CEMENT PANEL  
PRIMED AND PAINTED,  
COLOR: PANDA WHITE  
SW 6147

FIBERGLASS CORNICE  
ARCHITECTURAL  
FIBERGLASS C-332. NO  
CHANGE TO PROPOSED  
COLOR PALETTE

BRICK VENEER,  
GLEN-GERY: OLDE DETROIT

SIGNAGE TO BE DETERMINED  
AT A FUTURE DATE

BRICK REVEAL DETAIL

CAST STONE

SOLDIER COURSE DETAIL

ANODIZED ALUMINUM FIXED  
WINDOW, LOW-E GLASS,  
FRAME COLOR: DARK BRONZE,  
AWNING, COLOR: HOGAN  
ADMIRAL

ANODIZED ALUMINUM FIXED  
WINDOW, LOW-E GLASS,  
FRAME COLOR: DARK BRONZE

FIBER CEMENT AND MDO  
TRIM. COLOR: NEEDLEPOINT  
NAVY SW 0032

CAST STONE BASE

CANOPY, COLOR: BRONZE

BOLLARD (FLAT TOP), COLOR: BLACK

+ 71'-0"

+ 66'-11"

TOP OF ROOF  
71'-0"

ROOF  
61'-0"

PARAPET  
51'-11"

FIFTH FLOOR  
47'-10 1/4"

FOURTH FLOOR  
36'-7 5/8"

THIRD FLOOR  
25'-9 7/8"

SECOND FLOOR  
15'-0"

ARRISCRAFT -  
RENAISSANCE  
MASONRY UNITS,  
COLOR: LIMESTONE,  
FINISH: SATIN

FIRST FLOOR  
0'-0"

1

ELEVATION HOTEL - EAST ELEVATION

1" = 10'-0"

1" = 10'-0"

0 10' 20' 30'

PROJECT INFORMATION

MEDINA HOTEL - EVENT CENTER  
DATE: FEBRUARY 27, 2024  
PROJECT NO. 14423

PROPOSED

SHEET NAME

HOTEL - EAST EXTERIOR  
ELEVATION

SHEET NO.

HSK01







1 ELEVATION HOTEL - WEST ELEVATION  
1" = 10'-0"



MEDINA HOTEL - EVENT CENTER  
DATE: MAY 1, 2024  
PROJECT NO. 14423

PROJECT INFORMATION  
**APPROVED 10/10/24**

SHEET NAME  
HOTEL - WEST EXTERIOR  
ELEVATION

SHEET NO.  
HSK02





1 ELEVATION HOTEL - WEST ELEVATION  
1" = 10'-0"



MEDINA HOTEL - EVENT CENTER  
DATE: FEBRUARY 27, 2024  
PROJECT NO. 14423

PROJECT INFORMATION

**PROPOSED**

SHEET NAME

HOTEL - WEST EXTERIOR  
ELEVATION

SHEET NO.

HSK02



SLATE LOOK SHINGLE ROOF  
ECO STAR MAJESTIC SLATE  
TRADITIONAL CLASS C  
COLOR: CHESTNUT BROWN,  
FEDERAL GRAY, CEDAR  
BROWN, MOUNTAIN PLUM,  
DRIFTWOOD

FIBER CEMENT  
PANEL PRIMED AND  
PAINTED, COLOR:  
PANDA WHITE  
SW 6147

FIBERGLASS CORNICE  
ARCHITECTURAL  
FIBERGLASS C-332. NO  
CHANGE TO  
PROPOSED COLOR  
PALETTE

BRICK VENEER,  
GLEN-GERY: OLDE DETROIT

BRICK REVEAL DETAIL

STO LIMESTONE

SOLDIER COURSE  
DETAIL

ANODIZED ALUMINUM  
FIXED WINDOW, LOW-E  
GLASS,  
FRAME COLOR: DARK  
BRONZE

FIBERGLASS CORNICE  
ARCHITECTURAL  
FIBERGLASS C-332. NO  
CHANGE TO  
PROPOSED COLOR  
PALETTE

CANOPY, COLOR:  
DARK BRONZE

ARRISCRAFT -  
RENAISSANCE  
MASONRY UNITS,  
COLOR: LIMESTONE,  
FINISH: SATIN

CAST STONE BASE

ANODIZED ALUMINUM FIXED  
WINDOW, LOW-E GLASS,  
FRAME COLOR: DARK BRONZE

FIBERGLASS CORNICE  
ARCHITECTURAL FIBERGLASS  
C-345.  
COLOR:  
SW 6147 PANDA WHITE  
SW 0032 NEEDLEPOINT NAVY

TOP OF ROOF  
71'-0"

ROOF  
61'-0"

PARAPET  
53'-3"

FIFTH FLOOR  
47'-10 1/4"

FOURTH FLOOR  
36'-7 5/8"

THIRD FLOOR  
25'-9 7/8"

SECOND FLOOR  
15'-0"

FIRST FLOOR  
0'-0"

1 ELEVATION HOTEL - NORTH ELEVATION  
1" = 10'-0"



MEDINA HOTEL - EVENT CENTER  
DATE: MAY 1, 2024  
PROJECT NO. 14423

PROJECT INFORMATION

APPROVED 10/10/24

SHEET NAME

HOTEL - NORTH  
EXTERIOR ELEVATION

SHEET NO.

HSK03



SLATE LOOK SHINGLE ROOF  
ECO STAR MAJESTIC SLATE  
TRADITIONAL CLASS C  
COLOR: CHESTNUT BROWN,  
FEDERAL GRAY, CEDAR  
BROWN, MOUNTAIN PLUM,  
DRIFTWOOD

FIBER CEMENT  
PANEL PRIMED ANI+ 64'-5 1/2"  
PAINTED, COLOR:  
PANDA WHITE  
SW 6147

FIBERGLASS CORNICE  
ARCHITECTURAL  
FIBERGLASS C-358. NO  
CHANGE TO  
PROPOSED COLOR  
PALETTE

BRICK VENEER,  
GLEN-GERY: OLDE DETROIT

BRICK REVEAL DETAIL

CAST STONE

SOLDIER COURSE  
DETAIL

ANODIZED ALUMINUM  
FIXED WINDOW, LOW-E  
GLASS,  
FRAME COLOR: DARK  
BRONZE

FIBERGLASS CORNICE  
ARCHITECTURAL  
FIBERGLASS C-358.  
PANDA WHITE  
SW6147

CANOPY, COLOR:  
DARK BRONZE

ARRISCRAFT -  
RENAISSANCE  
MASONRY UNITS,  
COLOR: LIMESTONE,  
FINISH: SATIN

CAST STONE BASE

ANODIZED ALUMINUM FIXED  
WINDOW, LOW-E GLASS,  
FRAME COLOR: DARK BRONZE

FIBERGLASS CORNICE  
ARCHITECTURAL FIBERGLASS  
C-345.  
COLOR:  
SW 6147 PANDA WHITE  
SW 0032 NEEDLEPOINT NAVY

TOP OF ROOF  
71'-0"

ROOF  
61'-0"

FIFTH FLOOR  
47'-10 1/4"

FOURTH FLOOR  
36'-7 5/8"

THIRD FLOOR  
25'-9 7/8"

SECOND FLOOR  
15'-0"

FIRST FLOOR  
0'-0"

1 ELEVATION HOTEL - NORTH ELEVATION  
1" = 10'-0"



MEDINA HOTEL - EVENT CENTER  
DATE: FEBRUARY 27, 2024  
PROJECT NO. 14423

PROPOSED

SHEET NAME  
HOTEL - NORTH  
EXTERIOR ELEVATION

SHEET NO.  
HSK03



SLATE LOOK SHINGLE ROOF  
ECO STAR MAJESTIC SLATE  
TRADITIONAL CLASS C  
COLOR: CHESTNUT BROWN,  
FEDERAL GRAY, CEDAR  
BROWN, MOUNTAIN PLUM,  
DRIFTWOOD

FIBER CEMENT PANEL  
PRIMED AND PAINTED,  
COLOR: PANDA WHITE  
SW 6147

FIBERGLASS CORNICE  
ARCHITECTURAL  
FIBERGLASS C-345.  
COLOR:  
SW 6147 PANDA WHITE  
SW 0032 NEEDLEPOINT  
NAVY

BRICK VENEER,  
GLEN-GERY: OLDE DETROIT

STO LIMESTONE

BRICK REVEAL DETAIL

SOLDIER COURSE  
DETAIL

ANODIZED ALUMINUM FIXED  
WINDOW, LOW-E GLASS,  
FRAME COLOR: DARK  
BRONZE

FIBERGLASS CORNICE  
ARCHITECTURAL  
FIBERGLASS C-332. NO  
CHANGE TO PROPOSED  
COLOR PALETTE

ARRISCRAFT -  
RENAISSANCE  
MASONRY UNITS,  
COLOR: LIMESTONE,  
FINISH: SATIN

CAST STONE BASE

+ 71'-0"

+ 66'-11"

TOP OF ROOF  
71'-0"

ROOF  
61'-0"

PARAPET  
53'-3"

FIFTH FLOOR  
47'-10 1/4"

FOURTH FLOOR  
36'-7 5/8"

THIRD FLOOR  
25'-9 7/8"

CANOPY, COLOR:  
DARK BRONZE

SECOND FLOOR  
15'-0"

FIBER CEMENT AND  
MDO TRIM. COLOR:  
NEEDLEPOINT NAVY  
SW 0032

FIRST FLOOR  
0'-0"

1 ELEVATION HOTEL - SOUTH ELEVATION  
1" = 10'-0"



MEDINA HOTEL - EVENT CENTER  
DATE: SEPTEMBER 30, 2024  
PROJECT NO. 14423

PROJECT INFORMATION

APPROVED 10/10/24

SHEET NAME

HOTEL - SOUTH  
EXTERIOR ELEVATION

SHEET NO.

HSK04



SLATE LOOK SHINGLE ROOF  
ECO STAR MAJESTIC SLATE  
TRADITIONAL CLASS C  
COLOR: CHESTNUT BROWN,  
FEDERAL GRAY, CEDAR  
BROWN, MOUNTAIN PLUM,  
DRIFTWOOD

FIBER CEMENT PANEL  
PRIMED AND PAINTED,  
COLOR: PANDA WHITE  
SW 6147

FIBERGLASS CORNICE  
ARCHITECTURAL  
FIBERGLASS C-345.  
COLOR:  
SW 6147 PANDA WHITE  
SW 0032 NEEDLEPOINT  
NAVY

BRICK VENEER,  
GLEN-GERY: OLDE DETROIT

CAST STONE  
BRICK REVEAL DETAIL  
SOLDIER COURSE  
DETAIL

ANODIZED ALUMINUM FIXED  
WINDOW, LOW-E GLASS,  
FRAME COLOR: DARK  
BRONZE

FIBERGLASS CORNICE  
ARCHITECTURAL  
FIBERGLASS C-358.  
COLOR PANDA WHITE  
SW 6147

ARRISCRAFT -  
RENAISSANCE  
MASONRY UNITS,  
COLOR: LIMESTONE,  
FINISH: SATIN

CAST STONE BASE

+ 71'-0"

+ 66'-11"

TOP OF ROOF  
71'-0"

ROOF  
61'-0"

FIFTH FLOOR  
47'-10 1/4"

FOURTH FLOOR  
36'-7 5/8"

THIRD FLOOR  
25'-9 7/8"

SECOND FLOOR  
15'-0"

FIRST FLOOR  
0'-0"

CANOPY, COLOR:  
DARK BRONZE

FIBER CEMENT AND  
MDO TRIM. COLOR:  
NEEDLEPOINT NAVY  
SW 0032

1 ELEVATION HOTEL - SOUTH ELEVATION  
1" = 10'-0"



MEDINA HOTEL - EVENT CENTER  
DATE: FEBRUARY 27, 2024  
PROJECT NO. 14423

PROJECT INFORMATION

PROPOSED

SHEET NAME

HOTEL - SOUTH  
EXTERIOR ELEVATION

SHEET NO.

HSK04



























## 2602 - ONE LIGHT OUTDOOR WALL SCONCE



### Dimensions

|           |     |
|-----------|-----|
| Width     | 8"  |
| Height    | 22" |
| Extension | 9½" |

### Finish & Material

|          |   |
|----------|---|
| Finishes | <b>PBK</b> - Powder Coated Black<br><b>PBZ</b> - Powder Coated Bronze |
|----------|---|

|          |       |
|----------|-------|
| Material | Steel |
|----------|-------|

### Glass/Shade

|       |       |
|-------|-------|
| Glass | Clear |
|-------|-------|

### Wattage

|                |              |
|----------------|--------------|
| # Bulbs        | 1-Medium     |
| Bulbs Base     | Medium (E26) |
| Watts per Bulb | 60W          |
| Voltage        | 120V         |
| Bulbs Included | No           |

### Certification

|           |              |
|-----------|--------------|
| UL Listed | Wet Location |
|-----------|--------------|

### Item Number

|       |                      |
|-------|----------------------|
| SKU'S | 2602-PBK<br>2602-PBZ |
|-------|----------------------|



**Flickering bulb and  
Film applied to glass**

*"Making the Desirable Affordable"*



# Wall, Step , Path Light EL807

120 / 277 VOLT DIE-CAST ALUMINUM LED

Type:

Job:

Fixture Catalog number:

Approvals:

\_\_\_\_\_  
Fixture      Mode      Finish

## Specifications

**Housing:** Die-cast low copper alloy (<0.6% Cu) aluminum with clear anodized finish. Two 1/2" NPT in sides. Housing mounts into concrete, brick, or masonry (non-combustible materials). Internal splice area provided behind lamp plate.

**Lens Frame:** Die-cast aluminum, with silicone gasket, attaches to housing with two captive 10-32 stainless steel, hex socket cap screws.

**Lens:** Tempered prismatic glass with silicone gasket, concealed above lens frame opening.

**Finish:** On lens frame only, each luminaire receives a fade and abrasion resistant, electrostatically applied, thermally cured, triglycidal isocyanurate (TGIC) polyester powdercoat finish. Standard colors are Black (**BL**), Dark Bronze (**DB**), and Verde Green (**GR**).

**Optical System:** A total of 3 or 9 LED emitters are configured together as a module. Available in 3000K, 4200K, and 5100K.

**Driver:** Universal Voltage from 120 to 277V with a ±10% tolerance. -40° F. starting temperature. All drivers are Underwriters Laboratories recognized.

## ORDERING INFORMATION

| Fixture                     | Source               |
|-----------------------------|----------------------|
| EL807 / 3L3KUV <sup>1</sup> | 3.6W, 3 LED's, 3000K |
| EL807 / 3L4KUV <sup>1</sup> | 3.6W, 3 LED's, 4200K |
| EL807 / 3L5KUV <sup>1</sup> | 3.6W, 3 LED's, 5100K |

| Fixture                     | Source                |
|-----------------------------|-----------------------|
| EL807 / 9L3KUV <sup>1</sup> | 10.8W, 9 LED's, 3000K |
| EL807 / 9L4KUV <sup>1</sup> | 10.8W, 9 LED's, 4200K |
| EL807 / 9L5KUV <sup>1</sup> | 10.8W, 9 LED's, 5100K |


<sup>1</sup> Universal Voltage from 120 to 277V with a ±10% tolerance.  
For 5.3W, Max Amps. are .13 for 120V, .080 for 208V, .080 for 240V, .060 for 277V. For 10.8W, Max Amps. are .090 for 120V, .050 for 208V, .040 for 240V, .040 for 277V..

### Finish

| BL - Black

| DB - Dark Bronze

| GR - Verde Green

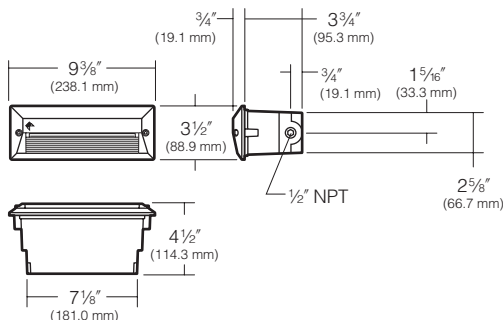

### Listings and Ratings

|                          |             |
|--------------------------|-------------|
| UL cUL 1598 <sup>1</sup> | 25C Ambient |
|--------------------------|-------------|

<sup>1</sup>Suitable for wet locations

# Wall, Step , Path Light EL807

120 / 277 VOLT DIE-CAST ALUMINUM LED

## Lumen Data

| Spectroradiometric             |               |               |               |
|--------------------------------|---------------|---------------|---------------|
|                                | 3000K         | 4200K         | 5100K         |
| Correlated Color Temp. CCT (K) | 2800 to 3175K | 3800 to 4600K | 4600 to 5600K |
| Color Rendering Index (CRI)    | ≥75           | ≥70           | ≥65           |

| ELECTRICAL - Drive Current @350mA (3 LEDs) |           |              |
|--|-----------|--------------|
| Volts -AC                                  | Amps - AC | System Watts |
| 120  | 0.13      | 5.3          |
| 208  | 0.08      | 5.3          |
| 240  | 0.08      | 5.3          |
| 277  | 0.06      | 5.3          |

| ELECTRICAL - Drive Current @350mA (9 LEDs) |           |              |
|--|-----------|--------------|
| Volts -AC                                  | Amps - AC | System Watts |
| 120  | 0.09      | 10.5         |
| 208  | 0.05      | 10.5         |
| 240  | 0.04      | 10.5         |
| 277  | 0.04      | 10.5         |

| Absolute Lumens (3 LEDs) |            |
|--------------------------|------------|
| Temperature              | EL807/3L*K |
| 3000K                    | 61         |
| 4200K                    | 71         |
| 5100K                    | 78         |

| Absolute Lumens (9 LEDs) |            |
|--------------------------|------------|
| Temperature              | EL807/9L*K |
| 3000K                    | 167        |
| 4200K                    | 188        |
| 5100K                    | 211        |

| Lumens Per Watt (3 LEDs) |            |
|--------------------------|------------|
| Temperature              | EL807/3L*K |
| 3000K                    | 11.5       |
| 4200K                    | 13.4       |
| 5100K                    | 14.7       |


| Lumens Per Watt (9 LEDs) |            |
|--------------------------|------------|
| Temperature              | EL807/9L*K |
| 3000K                    | 15.9       |
| 4200K                    | 17.9       |
| 5100K                    | 20.1       |







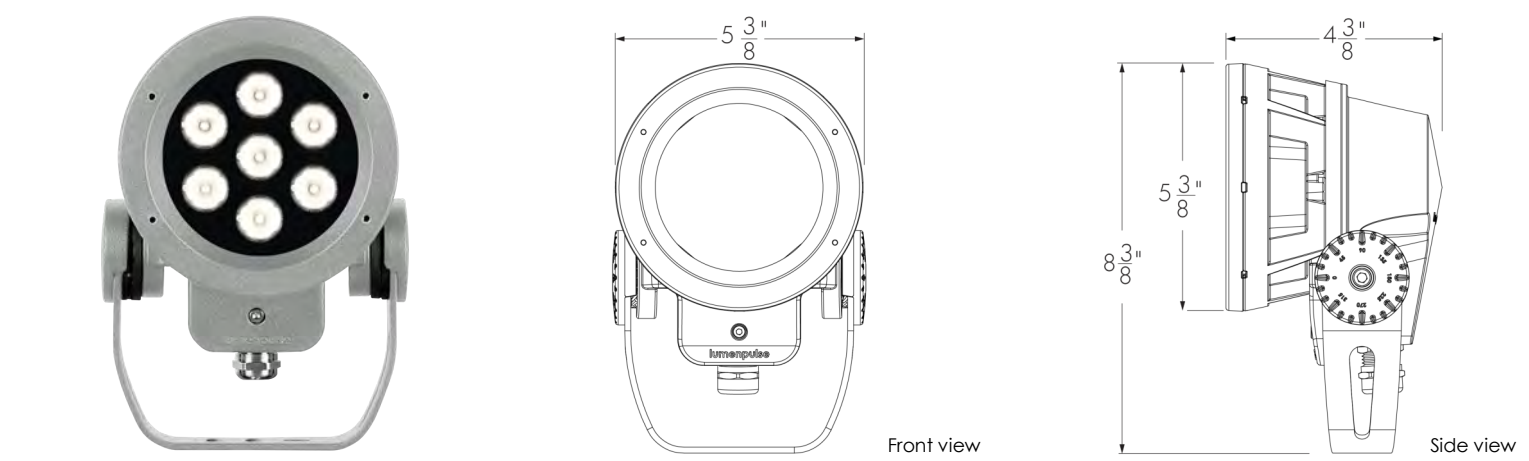


Project Name

Qty

Type

Catalog / Part Number



| Photometric Summary  |                       |                     | Description  |  |
|--|-----------------------|---------------------|--|--|
| Symmetric  |                       |                     | The Lumenbeam Small is a compact, IP66-rated luminaire for lighting landscapes, trees, columns, monuments, and architectural details. It has numerous options, including optics for flood or accent lighting, a choice of color temperatures and colors, as well as various accessories, spread lenses, and controls. The luminaire also has an anti-corrosion option for use in harsh, chemical, or coastal environments. |  |
|  | Delivered output (lm) | Intensity (peak cd) |  |  |
| XN (3°)  | 1,342                 | 186,978             |  |  |
| VN (6°)  | 906                   | 47,949              |  |  |
| NS (10°)   | 1,419                 | 20,764              |  |  |
| NF (20°)   | 1,238                 | 12,472              |  |  |
| M (30°)  | 1,297                 | 7,185               |  |  |
| FL (40°)   | 1,163                 | 2,960               |  |  |
| WFL (60°)  | 977                   | 762                 |  |  |
| Asymmetric   |                       |                     | Features   |  |
| NAS  | 947                   | 14,011 (@2.5°)      | Color and Color Temperature  |  |
| WW   | 1,106                 | 3,013 (@5°)         | Optics (Nominal Distribution)  |  |
| Based on 4000K configuration.<br>Photometric performance is measured in compliance with IESNA LM-79-08.      |                       |                     | Optical Option   |  |
|  |                       |                     | Mounting Option  |  |
|  |                       |                     | Option   |  |
|  |                       |                     | Cable Color  |  |
| Optic  |                       |                     | Power Consumption  |  |
|  |                       |                     | Warranty   |  |
|  |                       |                     | Performance  |  |
|  |                       |                     | Maximum Delivered Output   |  |
| <br>Extra<br>Narrow 3°     |                       |                     | Maximum Delivered Intensity  |  |
|  |                       |                     | Illuminance at Distance  |  |
|  |                       |                     | Color Consistency  |  |
|  |                       |                     | Color Rendering  |  |
| <br>Very<br>Narrow 6°     |                       |                     |  |  |
| <br>Narrow<br>Spot 10°    |                       |                     |  |  |
| <br>Narrow<br>Flood 20°   |                       |                     |  |  |
| <br>Medium<br>30°          |                       |                     |  |  |
| <br>Flood 40°             |                       |                     |  |  |
| <br>Wide<br>Flood 60°     |                       |                     |  |  |
| <br>Narrow<br>Asymmetric  |                       |                     |  |  |
| <br>Asymmetric<br>Wallwash |                       |                     |  |  |